PROPOSED NEW RESIDENCE





SHEET INDEX

COVER INDEX SK-01 SK-02 SITE PLAN FLOOR PLAN SK-03 SECTION AA / H1 CALC SK-04

SK-05 **ELEVATIONS ROOF PLAN** SK-06



IMPORTANT NOTE: ALL LANDSCAPING, PLANTING, LIGHTING AND FENCING IS SHOWN FOR IMAGING PURPOSES ONLY. REFER TO BUILDING CONTRACT AND "FIXTURES AND FITTINGS" FOR LANDSCAPING INCLUSIONS

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TITLE:		
GH		

IMPORTANT NOTE: THE SCHEDULE OF FIXTURES AND FITTINGS TAKES PRECEDENCE OVER THESE DRAWINGS

DRAWING TITLE: **COVER INDEX**

LEGAL DESCRIPTION: LOT:116 DP:570929 9 BOND STREET, **BLENHEIM**

LEGAL NOTES:	EXP Z
Subject to council approval All measurements to be confirmed on site by the contractor prior to the commencement of work	В
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LEGAL NOTES: 1. Subject to council approval 2. All measurements to be confirmed on site by the contractor prior to the commencement of work	EXP ZONE:	DES: TC	WIND ZONE: HIGH	JOB # ML0070
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GENERAL NOTES

SITE AREA 750m²

FLOOR AREA OVER FRAMING 192.47 m² FLOOR AREA OVER FOUNDATION 187.88 m² SITE COVERAGE AREA (OVER FOUNDATION INCL. COVERED AREAS) 190.81 m²

SITE COVERAGE (?% ALLOWABLE)

EXPOSURE ZONE WIND ZONE HIGH EARTHQUAKE ZONE N3 SNOW ZONE

TERRITORIAL AUTHORITY PLANNING ZONE MDC URBAN RESIDENTIAL 2

GENERAL: CONCEPT SUBJECT TO TA RULES AND REGULATIONS.

ALL DIMENSIONS TO BE CONFIRMED ON SITE

CONCEPT MAY BE SUBJECT TO SUBDIVISION DEVELOPER'S APPROVAL

ENGINEERED(WAFFLEPOD) FOUNDATION TYPE:

POSITION OF ROAD CROSSING, SERVICES LOCATIONS, STREET TREES, LAMP POSTS, PARKING BAYS, PEDESTRIAN ISLANDS ETC IS UNKNOWN - TO BE SITE INFORMATION:

CONFIRMED WHEN INFORMATION BECOMES AVAILABLE.

LANDSCAPING: THIS PLAN IS INDICATIVE ONLY.

LANDSCAPING TO BE CONFIRMED BY THE CLIENT.


ALL FENCING TO COMPLY WITH THE RELEVANT COVENANTS.

REFER TO LANDSCAPE ARCHITECTS PLAN.

CONFIRMED WITH RELEASE OF CERTIFICATE OF TITLE **BOUNDARY INFORMATION:**

SITE LEVELS: LEVELS AND OTHER RELEVANT SITE INFORMATION FOR THIS SITE TO BE

STORMWATER: COUNCIL CONNECTION AT BOUNDARY/SOAKPIT/RETENTION TANK/GREY WATER RECYCLING SEWER CONNECTION: COUNCIL CONNECTION AT BOUNDARY/ECOFLOW TANK/SEPTIC TANK SITE SERVICES:

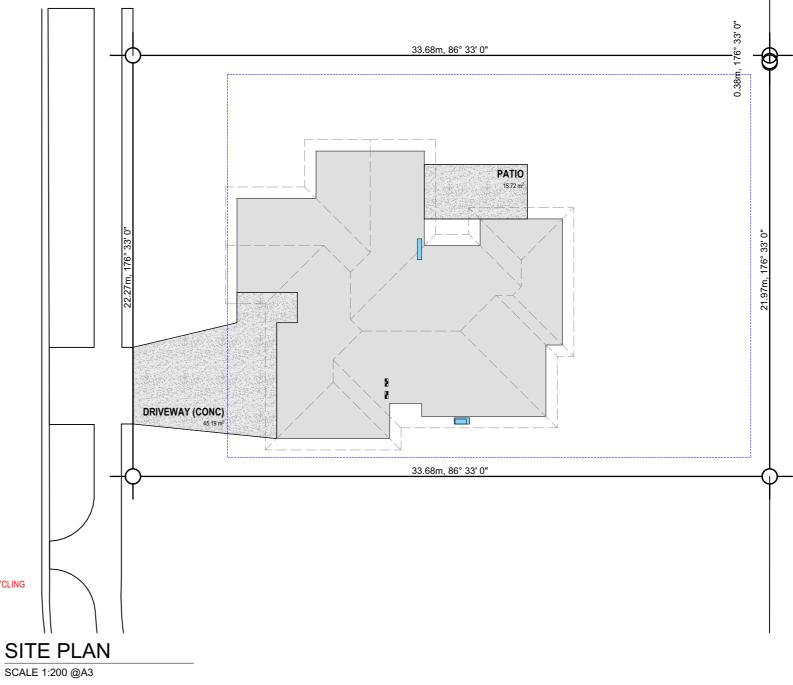

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JOB#

SHEET:

SK-02

ML0070

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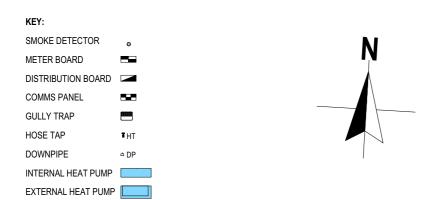
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JOB TITLE: MGH IMPORTANT NOTE: THE SCHEDULE OF FIXTURES AND FITTINGS TAKES PRECEDENCE OVER THESE DRAWINGS

DRAWING TITLE: **SITE PLAN** LEGAL DESCRIPTION: LOT:116 DP:570929 9 BOND STREET, **BLENHEIM**

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GENERAL NOTES

192.47m² FLOOR AREA OVER CLADDING: 71.260.0 mm PERIMETER (OVER FOUNDATION)

ROOF PITCH 25° EAVES WIDTH 600mm GABLE WIDTH 600mm HEIGHT TO UNDERSIDE OF TRUSS 2460mm LINTEL HEIGHT 2130mm SOFFIT HEIGHT 2145mm SOFFIT TYPE FLAT

INTERNAL DOOR LEAF HEIGHT STANDARD 2045 RO OR OVERHEIGHT

LININGS GIB(10mm TO WALLS 13mm TO CEILINGS)

35mm METAL CEILING BATTENS DIRECT FIXED @ 600mm CRS CEILING BATTENS

HEATING: HEAT PUMP TO BE FIXED IN POSITION SHOWN ON THE DRAWINGS. REFER TO SPECIFICATIONS FOR MORE INFORMATION.

CEILING VENTS: BATHROOM, ENSUITE & LAUNDRY TO VENTED DIRECTLY TO EXTERIOR RANGE HOOD TO EXIT THROUGH SOFFIT LINING

SMOKE ALARMS: REQUIRED WITHIN 3m OF ALL SLEEPING AREAS, CHANGE IN LEVEL & ENTRY/EXITS AS PER NZS 4514 & BRANZ BULLETINS

ADDITIONAL FLOOR PLAN NOTES:

- ALL GLAZING TO COMPLY WITH NZS4223
- ALL HARD FLOOR FINISHES AT MAIN ENTRANCE TO COMPLY WITH NZBC D1/AS TABLE 2.
- HOT WATER PIPES TO BE SIZED ACCORDING TO NZBC G12 & NZS4305:1996. MAINS PRESSURE: 15mm DIA. ALLOWS 12m MAX. PIPE LENGTH. PIPE LENGTH BEYOND THIS MUST BE LAGGED.
- SATIN ENAMEL WALL FINISH TO BATHROOM, ENSUITE & THOSE WALLS ADJACENT TO SINKS ETC. IN KITCHEN & LAUNDRY. IMPERVIOUS LINING TO BE USED ABOVE BASINS, VANITIES & BENCHES. BOTTOM EDGE TO BE FILLED WITH FUNGUS/MOULD RESISTANT SEALANT.

-ENSURE ALL SPACES WITHIN THE BUILDING ARE PROVIDED WITH ADEQUATE ARTIFICIAL LIGHTING (MIN. 20 LUX AT FLOOR LEVEL) TO ENABLE SAFE MOVEMENT IN THE ABSENCE OF NATURAL LIGHT -ALL DOWNLIGHTS FITTED TO HOUSE ARE TO BE IC-F CLASS (INSULATION OVER)

WATER PROOFING MEMBRANE NOTE:

SELECTED WATERPROOFING MEMBRANE REQUIRED TO BATHROOMS & REBATED/LEVEL ACCESS SHOWERS.



FLOOR PLAN

SCALE 1:100 @A3




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DRAWING TITLE: **FLOOR PLAN**

LEGAL DESCRIPTION: LOT:116 DP:570929 9 BOND STREET, **BLENHEIM**

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SECTION AA

INSULATION CALC DOES NOT INCLUDE GARAGE AREA (BATTS REQUIRED TO INTERNAL WALLS BETWEEN GARAGE AND HOUSE. SLAB AREA PERIMETER CORRECTION APPLIED

SCALE 1:50 @A3

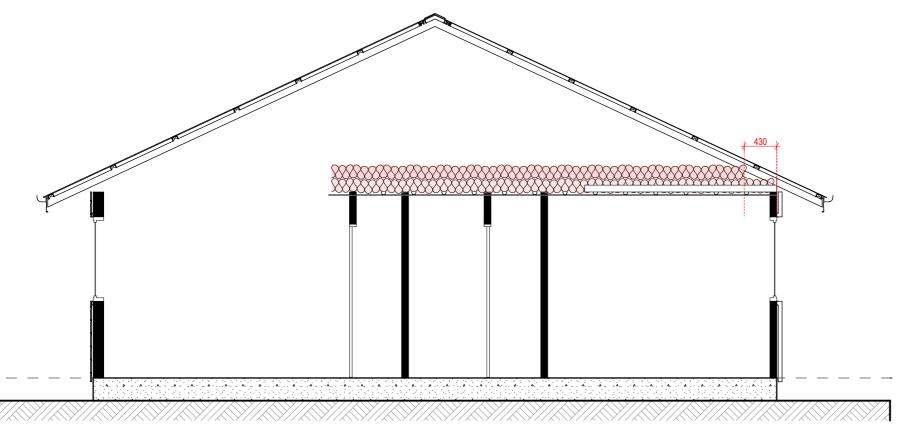BRANZ H1/AS1 5th Edition Calculation Method Spreadsheet - Results

Version: 21-Oct-2022 Client MGH ML070 Project name 9 BOND ST Address Designer Date **Territorial Authority** Climate Zone Marlborough District When submitted After 2 November 2023 Application Housing **Proposed Building** Area **Proposed Building Heat Loss** Element (m²) (W/K) Slab Floors 107.1 151.0 Other Floors 0.0 0.0 Roof 151.0 23.6 Skylights 0.0 0.0 Walls 121.6 46.2 Glazing (walls & doors) (26.1% of total wall area) 43.6 94.8 1.7 Doors (opaque) 1.0 Total 272.7 Reference Building **Reference Building Heat Loss** Area (m²) (W/K) Element Slab Floors 151.0 100.7 Other Floors 0.0 0.0 Total Roof (includes skylight area) 151.0 22.9 Walls (70% of total wall area) 116.8 58.4 Glazing allowance (30% of total wall area) 50.1 108.8

0.37 THERMALLY IMPROVED 0.46 THERALLY BROKEN OPAQUE DOOR VALUE 0.56 (PARKWOOD THERMATECH)

Embed

No

No

No

No

heating?

Area

(m²)

151.0

133.0

18.0

101.0

20.6

1.4

1.7

1.7

4.1

1.7

1.7

1.7

7.5

2.2

5.1

1.0

1.7

2.2

2.2

1.8

0.9

0.9

2.0

1.7

1.7

Construction R-value

(m².K/W)

1.4

7.3

3.4

2.9

1.8

0.46

0.46

1.72

Heat Loss

(W/K)

107.1

18.3

5.3

34.6

11.6

3.0

3.8

3.8

8.9

3.8

3.8

3.8

16.3

4.9

11.2

2.2

3.8

4.9

4.9

3.9

2.0

2.0

4.3

3.8

1.0

Errors

GLASS CONSTRUCTION VALUE SEE TABLE E.1.1.1.1 OF H1 FIFTH EDITION

Comparison of proposed building against the reference building

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SECTION AA / H1 CALC

Total

PASS

LEGAL DESCRIPTION	
LOT:116	DP:570929
9 BOND STF	REET,
BLENHEIM	

Element type

Glazing (walls & doors)

Glazing (walls & doors)

8 Glazing (walls & doors)

Glazing (walls & doors)

10 Glazing (walls & doors)

11 Glazing (walls & doors)

Glazing (walls & doors)

Glazing (walls & doors)

Glazing (walls & doors)

15 Glazing (walls & doors)

Glazing (walls & doors)

17 Glazing (walls & doors)

18 Glazing (walls & doors)

19 Glazing (walls & doors)

Glazing (walls & doors)

Glazing (walls & doors)

Glazing (walls & doors)

23 Glazing (walls & doors)

Glazing (walls & doors)

25 Doors (opaque)

26 Doors (opaque)

Slab Floors

2 Roof

3 Roof

4 Walls

5 Walls

Description

2X3.6

RAFT NO EDGE


OBLIQUE 2.6

ENTRY SIDELIGHT

1X 3.6 PERIMETER

ROCK XTHERM GOLD 2.6

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NORTH

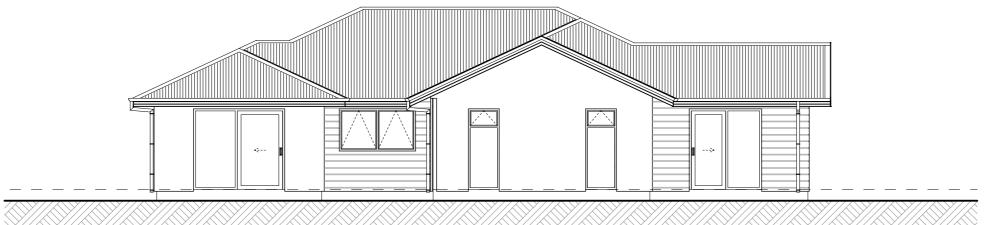SCALE 1:100 @A3

JOINERY

JOINERY
- ALL JOINERY FROM DOUBLE GLAZED(EXCEPT GARAGE) POWDER
COATED ALUMINIUM. TO COMPLY WITH NZS4223.JOINERY
MANUFACTURER TO VERIFY ALL SIZES ON SITE, SIZES NOMINATED ON
FLOOR PLAN ARE OPENING SIZES JOINER AND OWNER ALL TO AGREE
CONFIGURATION OF GLAZING PRIOR TO MANUFACTURE.
DOOR PANEL SIZES MAY NOT BE EVEN WIDTHS AS SHOWN IN THESE
ELEVATIONS
0 = OPAQUE GLASS - VERIFY WITH OWNER
S.G. = SAFETY GLASS REQ.
R.S. = RESTRICTOR STAYS

CLADDING GENERAL SOME CLADDING PRODUCTS REQUIRE HORIZONTAL OR VERTICAL JOINERS THAT WILL NOT BE SHOWN IN ELEVATIONS

RCS ROCKCOTE MODIFIED PLASTER


MESH REINFORCED PLASTER OVER 50mm POLYSTYRENE ON CAVITY BATTEN SYSTEM OVER BUILDING WRAP TO FRAMING.

CONTROL JOINTS TO OCCUR

WHERE THE WALL LENGTH IS GREATER THAN 8 METRES IN LENGTH A CONTROL JOINT WILL NEED TO BE INSTALLED OR WHERE A TWO STOREY DWELLING WALL HEIGHT EXCEEDS 6 METRES A HORIZONTAL CONTROL JOINT IS REQUIRED

JH OBLIQUE W/BOARD (HORIZONTAL) 175mm WIDTH

JAMES HARDIE OBLIQUE WIBOARD ON 20mm CAVITY OVER BUILDING WRAP TO FRAME SEE FIXING DETAILS IN ATTACHED SPECIFICATION.

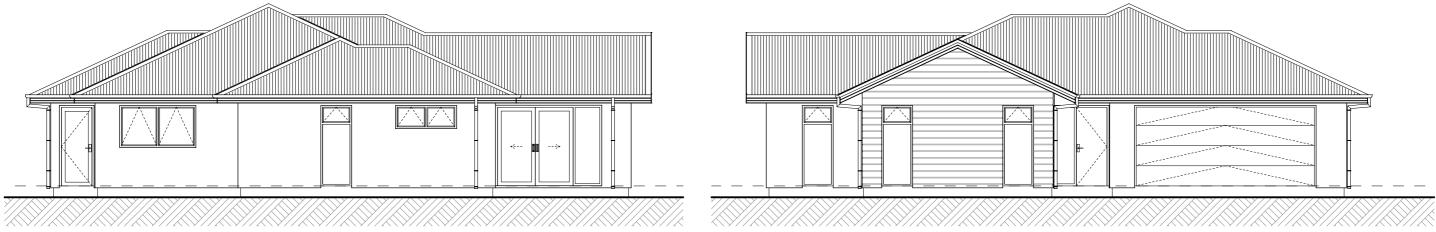


EAST

SCALE 1:100 @A3

WEST

SCALE 1:100 @A3

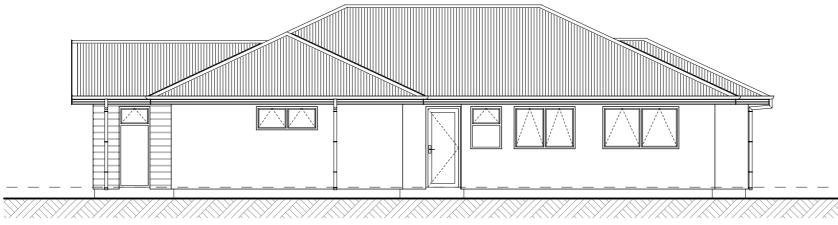

SOUTH

SCALE 1:100 @A3

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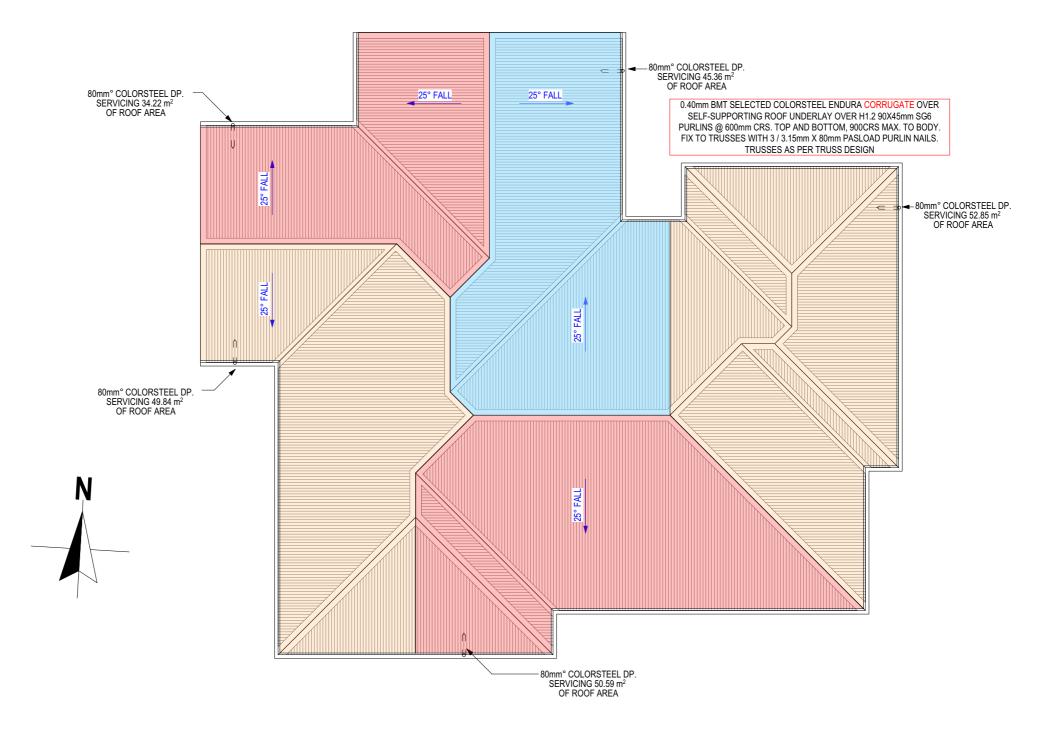
DRAWING TITLE:
ELEVATIONS

LEGAL DESCRIPTION: LOT:116 DP:570929 9 BOND STREET, **BLENHEIM**

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prior to the commencement of work	ľ
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ROOF PLAN

SCALE 1:100 @A3

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DRAWING TITLE:	
ROOF PL	AN

EGAL DESCRIPTION:			
LOT:116	DP:570929		
9 BOND STREET,			
BLENHEIM			

LEGAL NOTES:	EXP ZONE
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